JENSEN CREEK ACCLIMATION POND CONSTRUCTION PLANS



SECTION 16, TOWNSHIP 19 NORTH, RANGE 08 EAST, W.M., PIERCE COUNTY, WASHINGTON.

PROJECT CONTACTS

CONSULTANTS

ENGINEER
DAVID EVANS AND ASSOCIATES, INC.
3700 PACIFIC HIGHWAY EAST, SUITE 311 TACOMA, WASHINGTON 98424

PHONE: (253) 922-9780 CONTACT: MARC PUDISTS, P.E.

SURVEYOR
DAVID EVANS AND ASSOCIATES, INC.
3700 PACIFIC HIGHWAY EAST,

SUITE 311
TACOMA, WASHINGTON 98424
PHONE: (253) 922-9780
CONTACT: SEAN DOUTHETT, P.L.S.

PROPERTY OWNERS

PROPERTY OWNER
HANCOCK FOREST MANAGEMENT
ATTN: MR. ROBERT BASS 31716 CAMP 1 ROAD EAST ORTING, WA 98360 PHONE: (360) 879-4200

PROJECT OWNER
PUYALLUP TRIBE OF INDIANS
FISHERIES DEPARTMENT ATTN: MR RUSS LADIFY 6824 PIONEER WAY EAST PUYALLUP WA, 98371 PHONE: (253) 680-5560

ENUMCLAW 10 MILES GREENWATER 9 MILES PROJEC

VICINITY MAP

SHEET INDEX

	SUEE! INDEX	
SHEET NO.	DESCRIPTION	SHEET NAME
1	COVER SHEET	CV
2	EXISTING CONDITIONS (DEA SURVEY)	SV1
3	SITE PLAN	C1
4	DRIVEWAY PROFILE & POND SECTIONS	C2
5	WATER PIPELINE PROFILE	C3
6	WATER INTAKE PLAN AND DETAILS	C4
7	WATER INTAKE DETAILS	C5
8	MISCELANEOUS DETAILS	C6
9	CONCRETE STRUCTURE PLAN & SECTIONS	S1
10	CONCRETE STRUCTURE SECTIONS & DETAILS	S2

HORIZONTAL CONTROL: NAD 83/91 VERTICAL CONTROL: NGVD 29







REVISIONS:	APPD
-	
-	
	_
DATE: JUNE, 2011	

DESIGN: $\mathbf{CHECKED} \colon$ REVISION

SCALE:

PROJECT NUMBER: PTOI00000011

eccv001ptoi0011.dwg



EXISTING CONDITIONS MAP





DAVID EVANS
D ASSOCIATES INC.
700 Pacific Hwy. East, Suite 311
Tacoma Westington 98424
Phone: 253,922,9780

REVISIONS: APPD.

DATE: JUNE, 2011
DESIGN:
DRAWN: SMD
CHECKED: MAP
REVISION


SCALE:


PROJECT NUMBER: PTOI00000011

DRAWING FILE: svtp002ptoi0011.dwg

SHEET NAME

SV1SHEET 2 OF 10

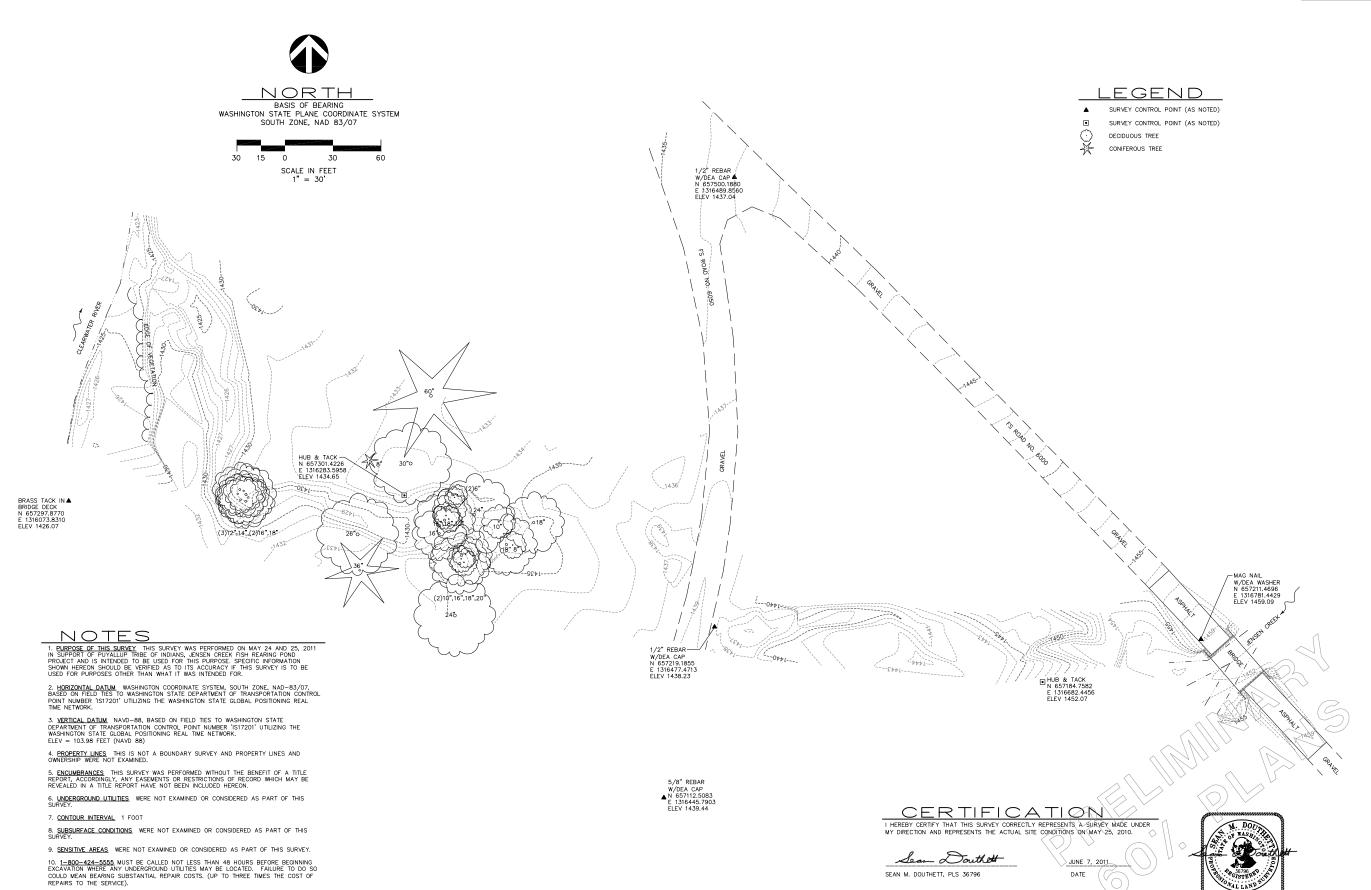

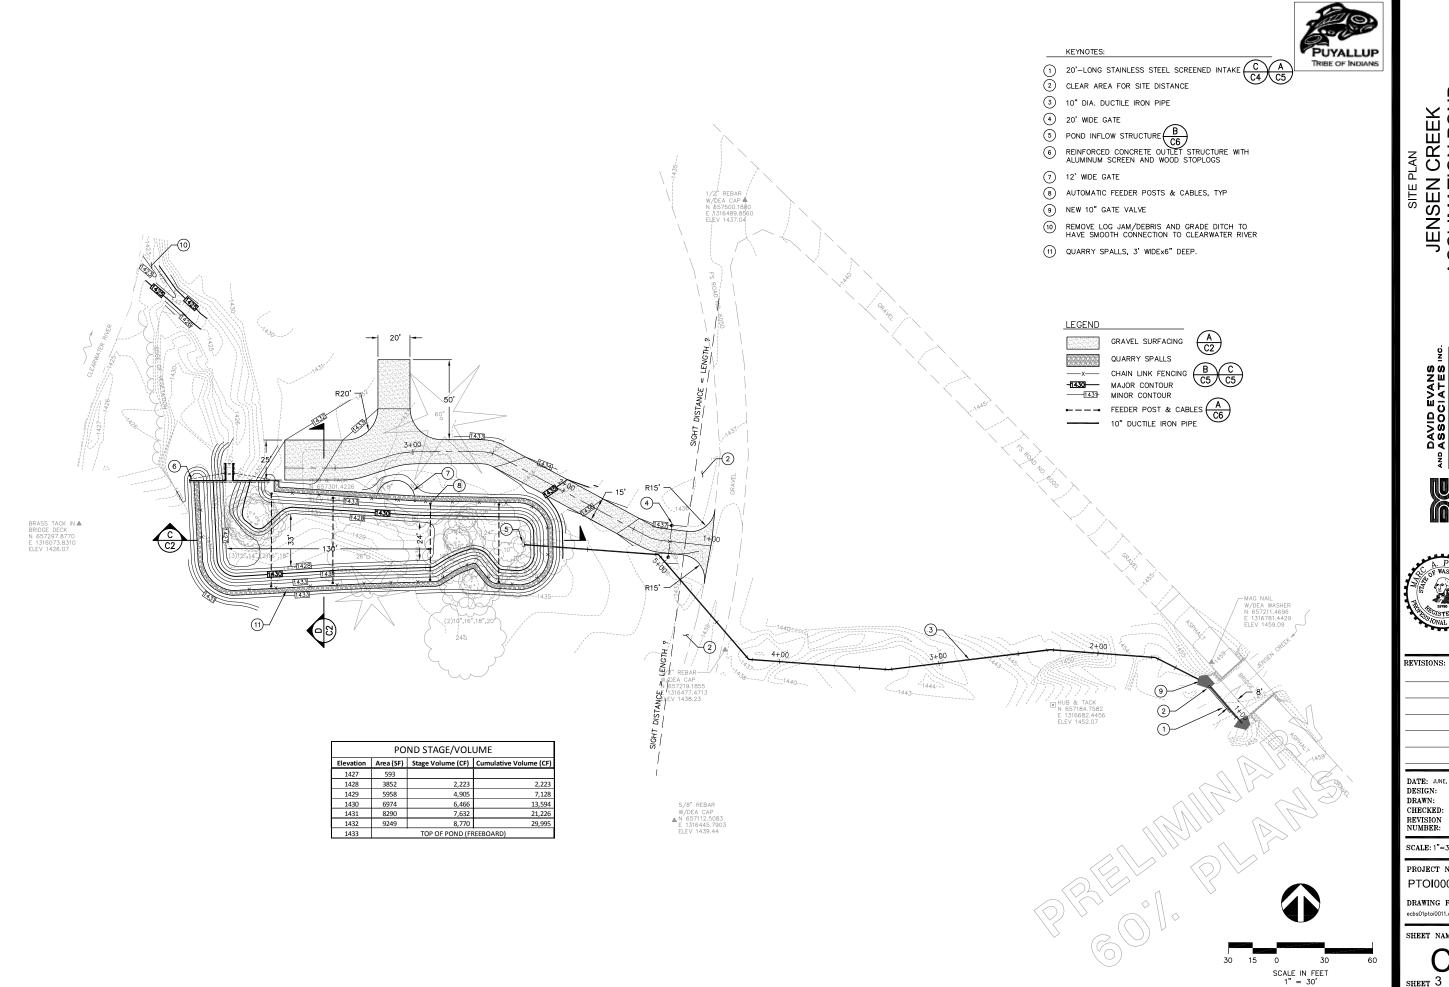

JENSEN CREEK
ACCLIMATION POND
PUYALLUP TRIBE OF INDIANS
PIERCE COUNTY, WASHINGTON





DATE: JUNE, 2011 DESIGN: AXI CHECKED:REVISION NUMBER:

SCALE: 1"=30'

PROJECT NUMBER: PTOI00000011

DRAWING FILE: ecbs01ptoi0011.dwg

SHEET NAME


SHEET 3 OF 10




PROPOSED GRAVEL ROAD SECTION

CRUSHED SURFACING BASE COURSE 12" DEEP


ALL FILL UNDER ROAD BASE SHALL USE "GRAVEL BORROW" PER WSDOT SPEC

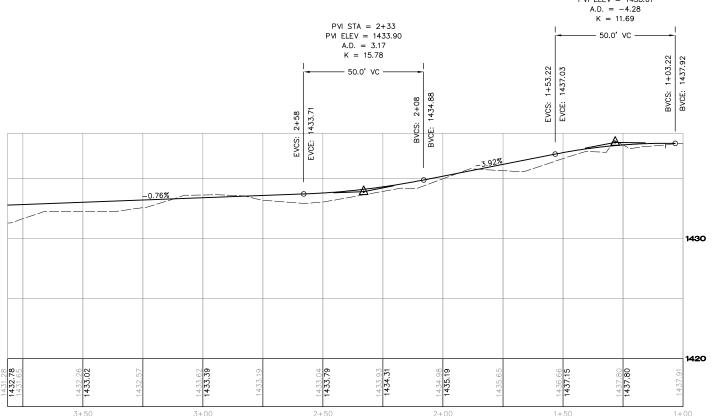


В PROPOSED GRAVEL ROAD PROFILE

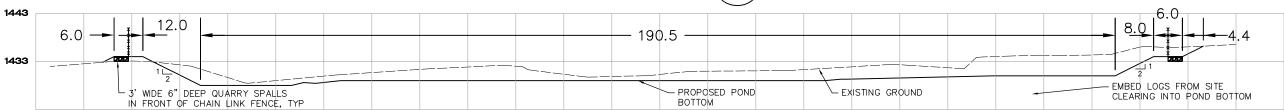

POND SECTION

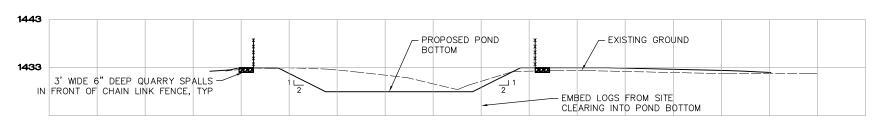

POND SECTION

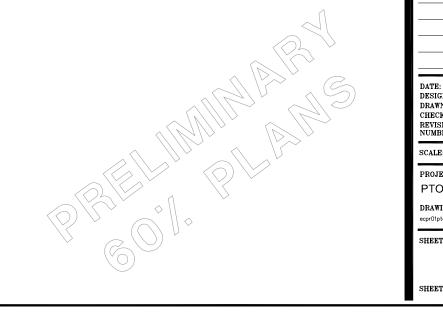

REVISIONS: APPD.

DATE: JUNE, 2011 DESIGN: AXE AXHA CHECKED: REVISION NUMBER:


SCALE:

PROJECT NUMBER: PTOI00000011

DRAWING FILE: ecpr01ptoi0011.dwg

SHEET NAME



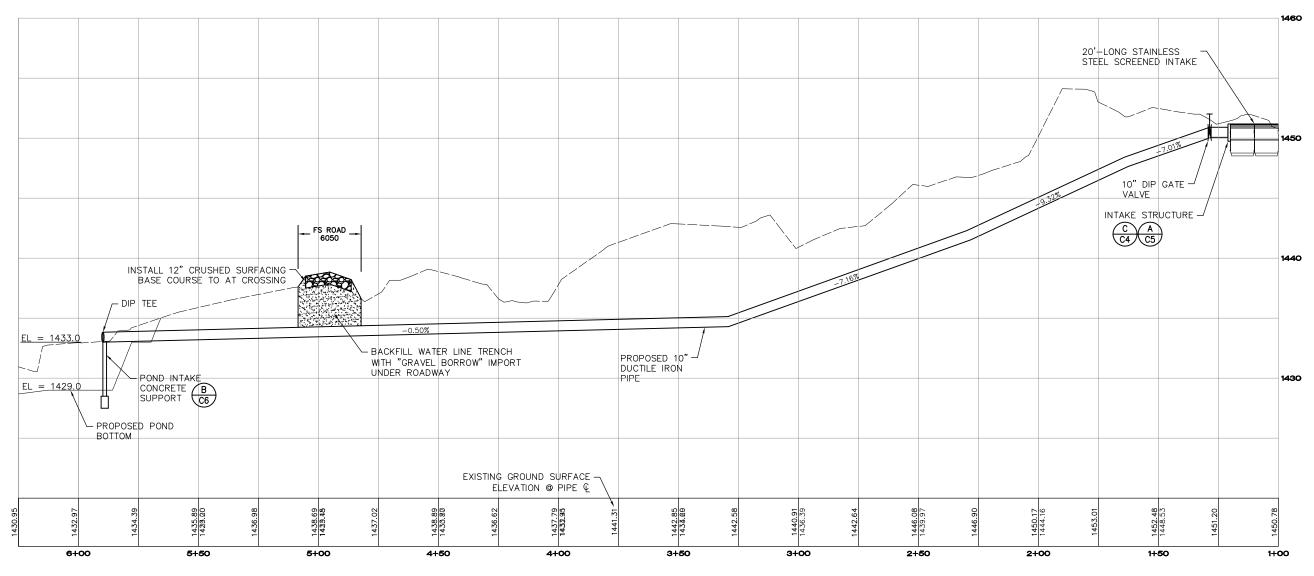

PROPOSED WATERLINE PROFILE

NATIVE SOIL BACKFILL (COBBLE, GRAVEL, SAND) ABOVE PEA GRAVEL \ FEXISTING 3' BURIAL DEPTH, TYP. 10"-DIA. DUCTILE IRON WATER SUPPLY PIPE-PEA GRAVEL SURROUNDS PIPE MINIMUM 3" THICK TYPICAL PIPE

TYPICAL WATERLINE SECTION

P₁ P₁

JENSEN CREEK ACCLIMATION POND PUYALLUP TRIBE OF INDIANS PIERCE COUNTY, WASHINGTON PROPOSED WATERLINE PROFILE



A PUI A PUI OF WASHING TO THE PUI OF WASHING TO THE PUI OF WASHING TO THE PUI OF WASHINGTON TO T	STS WELL
REVISIONS:	APPD.

		_
DATE: JUNE,	2011	
DESIGN:	AXHA	
DRAWN:	CDB	
CHECKED:		
REVISION		
NUMBER:		


SCALE:


PROJECT NUMBER: PTOI00000011

DRAWING FILE: ecpr01ptoi0011.dwg

SHEET NAME

SHEET 5 OF 10

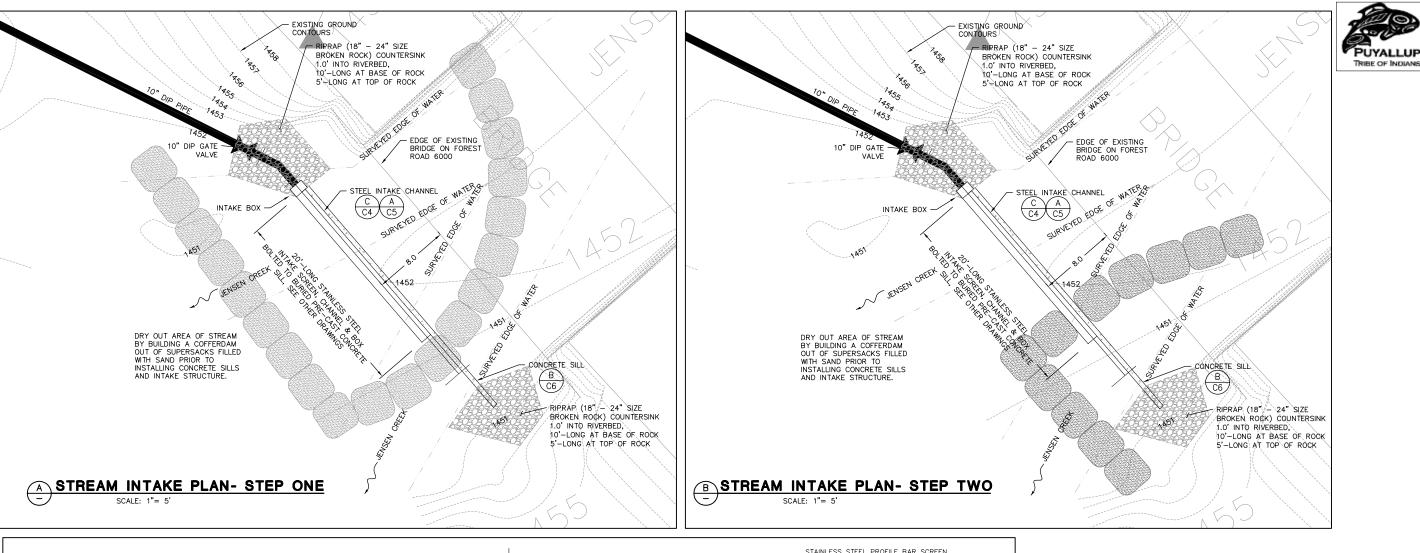

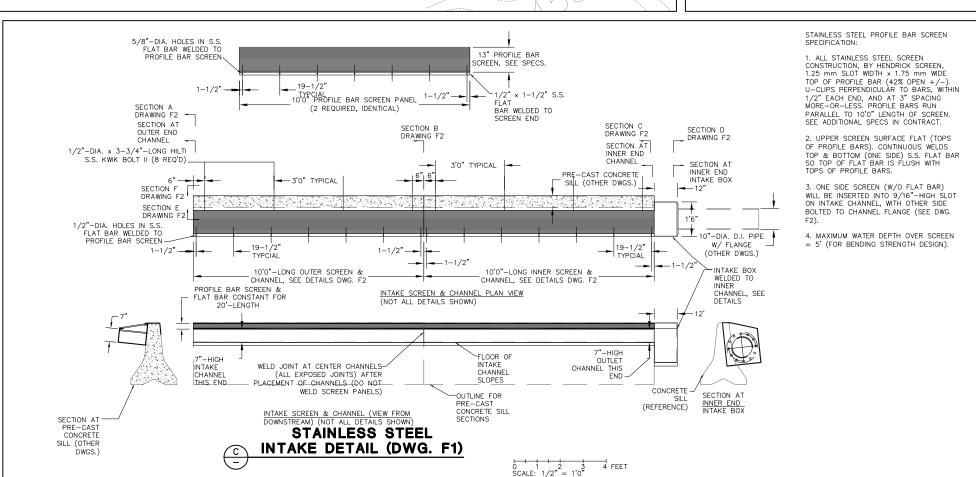

INTAKE CHANNEL & BOX NOTES:

- 1. "OUTER CHANNEL" AND "INNER CHANNEL" SHALL BE TWO COMPLETELY SEPARATE FABRICATIONS, WITH THE INTAKE BOX WELDED TO ONE SIDE OF THE "INNER CHANNEL" (SEE DWGS F1 & F2).
- 2. FOR ON-SITE ASSEMBLY, SET PRE-CAST CONCRETE SILL SECTIONS FIRST, THEN PLACE, "INNER CHANNEL" WITH INTAKE BOX AGAINST END OP CONCRETE PIECE. ATTACH "INNER CHANNEL" TO CONCRETE WITH ANCHOR BOLTS (SEE NOTE BELOW), THEN PLACE AND ANCHOR "OUTER CHANNEL", OUTER CHANNEL BUTTS UP TO INNER CHANNEL WITH 1/16"-WIDE GAP +/-. WELD EXPOSED JOINTS BETWEEN INNER AND OUTER CHANNEL PLATES.
- 3. ATTACH CHANNELS TO CONCRETE WITH EIGHT 1/2"-DIA. x 3-3/4" LONG S.S. ANCHOR BOLTS, SEE DWG. F1.
- 4 BOLT DUCTLE IRON PIPE FLANGE TO INTAKE BOX WITH DUCTILE IRON SPOOL & FLANGE COMPLETELY SUPPORTED. THEN INSERT SCREEN PANELS AND BOLT TO CHANNEL ASSEMBLIES.
- -5, BOLTS TO ATTACH SCREEN PANELS = FOURTEEN 3/8"-DIA. x 1-1/2" LONG S.S. HEX HEAD BOLTS.

DAVID EVANS
AND ASSOCIATES II
3700 Pacific Hwy. East, Suite 31
Tacoma Washington 99424
Phone: 25392229780

JENSEN CREEK
ACCLIMATION POND
PUYALLUP TRIBE OF INDIANS
PIERCE COUNTY, WASHINGTON

PLAN AND DETAILS

WATER INTAKE



REVISIONS:	APP

DATE: JUNE, 2011
DESIGN: AXHA
DRAWN: CDB
CHECKED:
REVISION
NUMBER:


SCALE: 1"=30'

PROJECT NUMBER: PTOI00000011

DRAWING FILE: ecdt01ptoi0011.dwg

SHEET NAME

C4
sheet 6 of 10

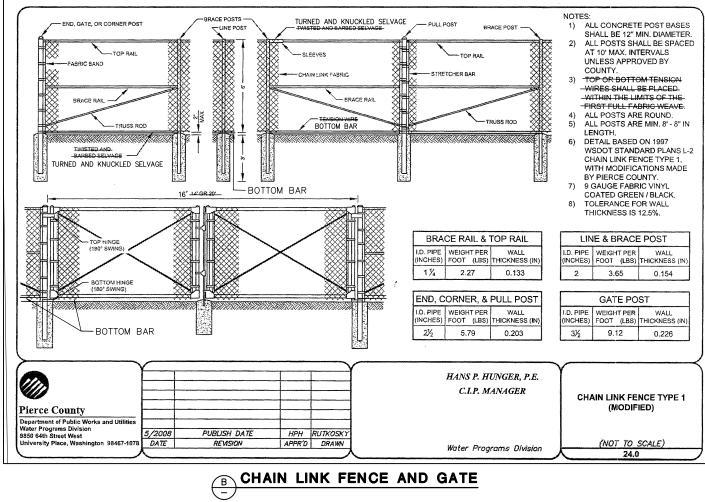

STAINLESS STEEL A INTAKE DETAIL (DWG. F2)


INTAKE CHANNEL & BOX NOTES:

1. "OUTER CHANNEL" AND "INNER CHANNEL" SHALL BE TWO COMPLETELY SEPARATE FABRICATIONS, WITH THE INTAKE BOX WELDED TO ONE SIDE OF THE "INNER CHANNEL" (SEE DWGS F1 &

2. FOR ON-SITE ASSEMBLY, SET PRE-CAST CONCRETE SILL SECTIONS FIRST. THEN PLACE "INNER CHANNEL" WITH INTAKE BOX AGAINST END OF CONCRETE PIECE. ATTACH "INNER CHANNEL" TO CONCRETE WITH ANCHOR BOLTS (SEE NOTE BELOW), THEN PLACE AND ANCHOR "OUTER CHANNEL". OUTER CHANNEL BUTTS UP TO INNER CHANNEL WITH 1/16"-WIDE GAP +/-. WELD EXPOSED JOINTS BETWEEN INNER AND OUTER CHANNEL PLATES.

- 3. ATTACH CHANNELS TO CONCRETE WITH EIGHT 1/2"-DIA. x 3-3/4" LONG S.S. ANCHOR BOLTS, SEE DWG. F1.
- 4. BOLT DUCTILE IRON PIPE FLANGE TO INTAKE BOX WITH DUCTILE IRON SPOOL & FLANGE COMPLETELY SUPPORTED. THEN INSERT SCREEN PANELS AND BOLT TO CHANNEL ASSEMBLIES.
- 5. BOLTS TO ATTACH SCREEN PANELS = FOURTEEN 3/8"-DIA. x 1-1/2" LONG S.S. HEX HEAD BOLTS.

FENCING NOTES ALL FENCE HARDWARE, FABRIC, AND POSTS SHALL BE BLACK VINYL CLAD OR BLACK POWDER COATED. ALL METALS SHALL BE HOT-DIP GALVANIZED PRIOR TO COATING. FENCE SHALL BE TURNED & KNUCKED SELVAGE TOP AND BOTTOM. MAXIMUM FENCE POST SPACING SHALL BE TEN FEET ON CENTER. ALL POSTS SHALL BE SET IN 3' DEEP 12" DIAMETER CONCRETE FOUNDATIONS. ALL FENCE HARDWARE, FABRIC, AND

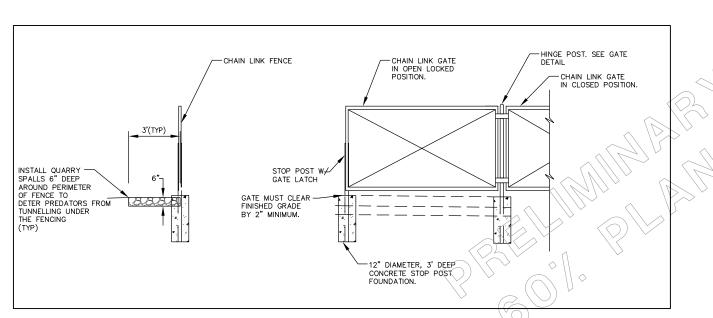

CHAIN LINK FENCE SECTION

TRIBE OF INDIANS

PUYALLUP

WATER INTAKE DETAILS
JENSEN CREEK
ACCLIMATION POND
PUYALLUP TRIBE OF INDIANS
PIERCE COUNTY, WASHINGTON

DAVID EVANS

ASSOCIATES II
Toons Weshington 89424
Phone: 2539229780





REVISIONS:		APPD.	
DATE: JUNE,	2011		
DESIGN:	AXHA		
DRAWN:	CDB		

CHECKED: REVISION NUMBER


SCALE: 1"=30'


PROJECT NUMBER: PTOI00000011

DRAWING FILE: ecdt01ptoi0011.dwg

SHEET NAME

SHEET 7 OF 10

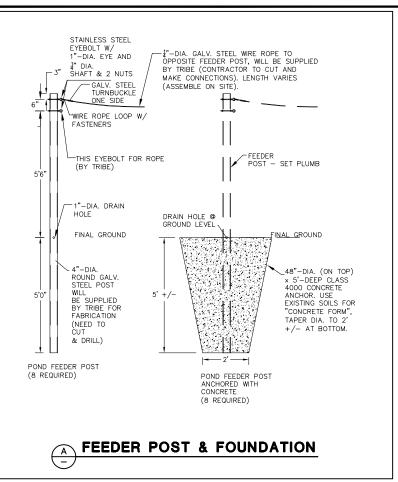

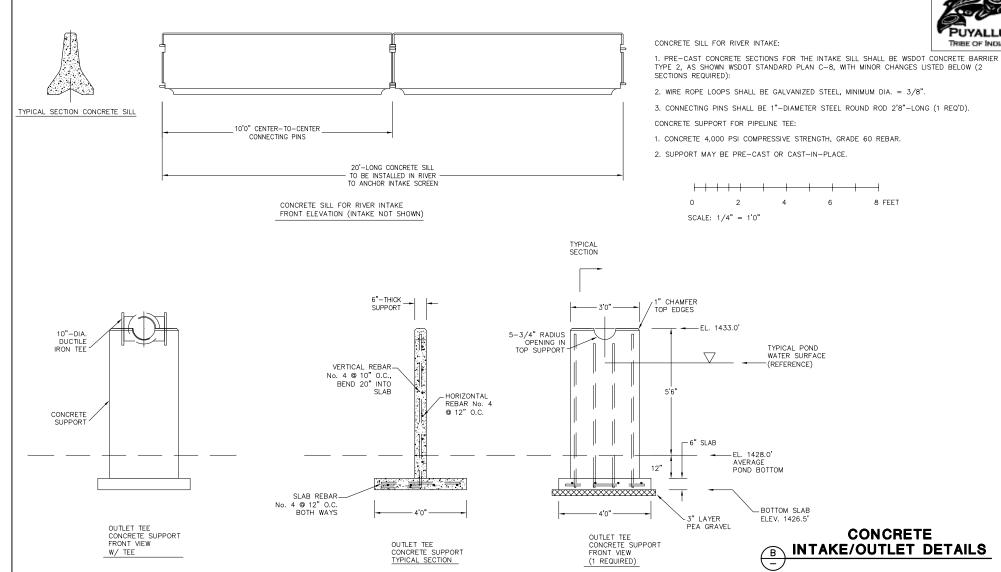

(1 REQUIRED)

DAi. DEST

TRIBE OF INDIANS

JENSEN CREEK ACCLIMATION POND PUYALLUP TRIBE OF INDIANS PIERCE COUNTY, WASHINGTON





REVISIONS:	APPD

DATE: JUNE, 2011 DESIGN: CHECKED: REVISION


NUMBER: SCALE: 1"=30'


PROJECT NUMBER: PTOI00000011

DRAWING FILE: ecdt02ptoi0011.dwg

SHEET NAME

C6 SHEET 8 OF 10

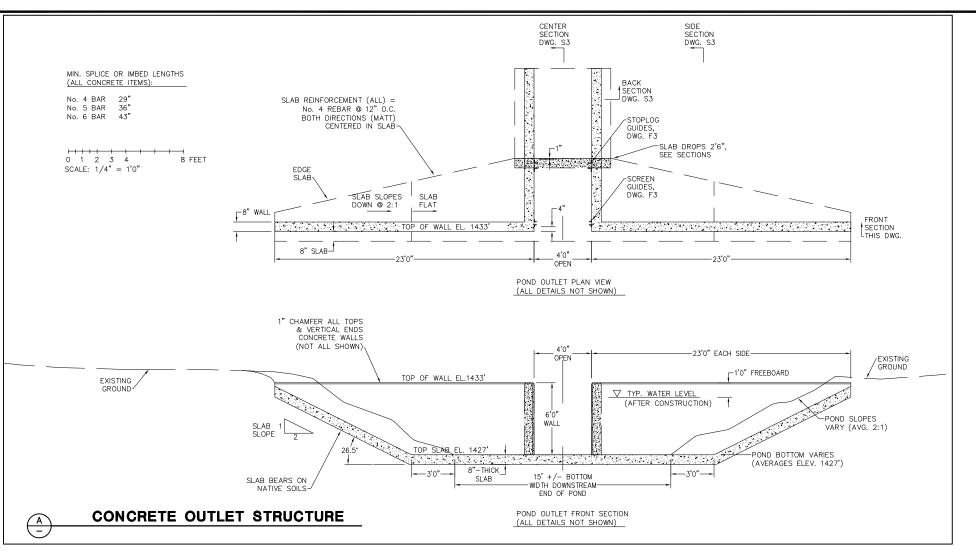

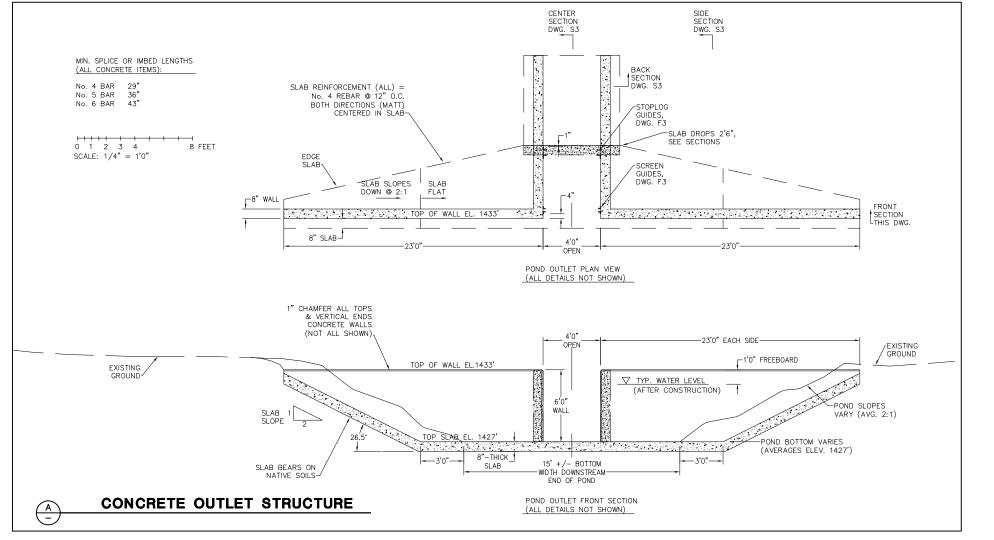



JENSEN CREEK
ACCLIMATION POND
PUYALLUP TRIBE OF INDIANS
PIERCE COUNTY, WASHINGTON





REVISIONS:	APPD
	 -
DATE: JUNE. 20	011
	AXHA

CHECKED: REVISION NUMBER:


SCALE: 1"=30'

PROJECT NUMBER: PTOI00000011

DRAWING FILE: ecdt02ptoi0011.dwg

SHEET NAME

S1 SHEET 9 OF 10

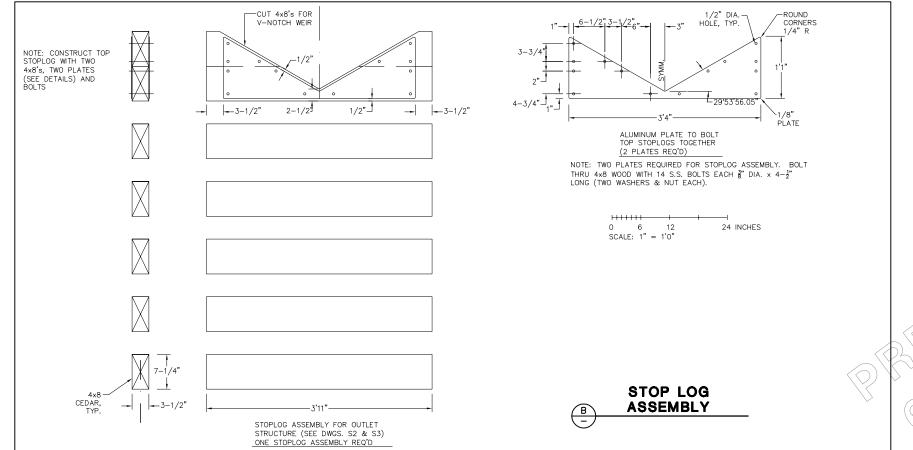



JENSEN CREEK
ACCLIMATION POND
PUYALLUP TRIBE OF INDIANS
PIERCE COUNTY, WASHINGTON **OUTLET DETAIL**

DAVID EVANS
ASSOCIATES
Tooms Washington 98424





REVISIONS:

DATE: JUNE,	2011	
DESIGN:	AXHA	
DRAWN:	CDB	
CHECKED:		
REVISION		

APPD.

NUMBER: SCALE: 1"=30'

PROJECT NUMBER: PTOI00000011

DRAWING FILE: ecdt02ptoi0011.dwg

SHEET NAME

S2 SHEET 10 OF 10